



FRONT ELEVATION (SCALE 1:75) (Rear Platform Removed for Clarity)

PLAN VIEW (SCALE 1:75)

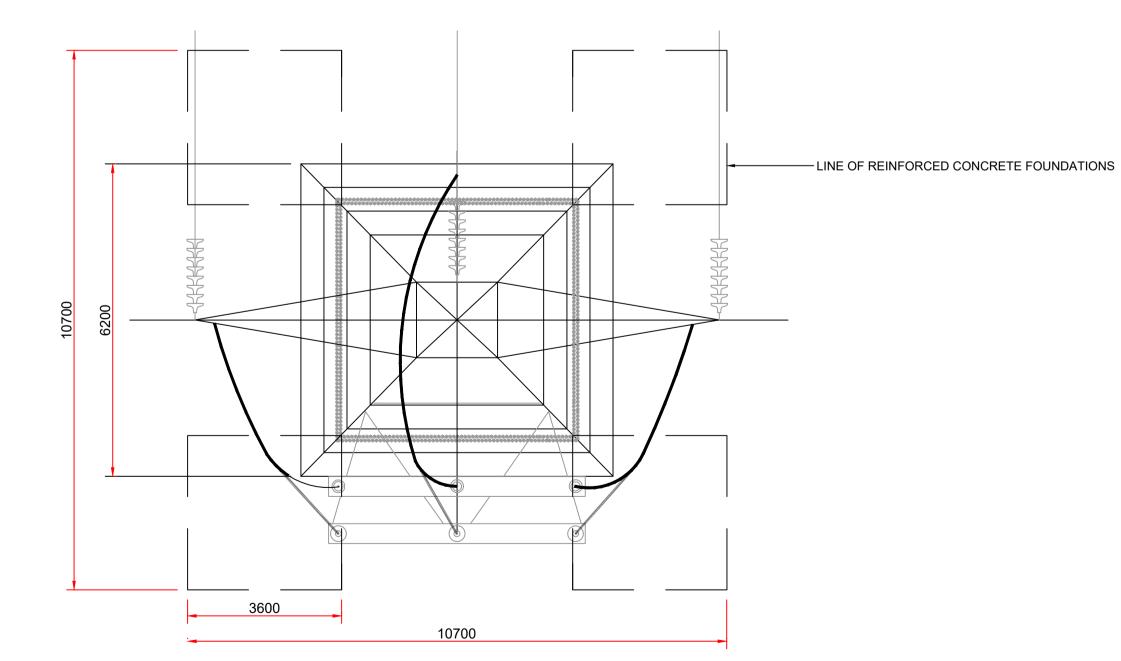

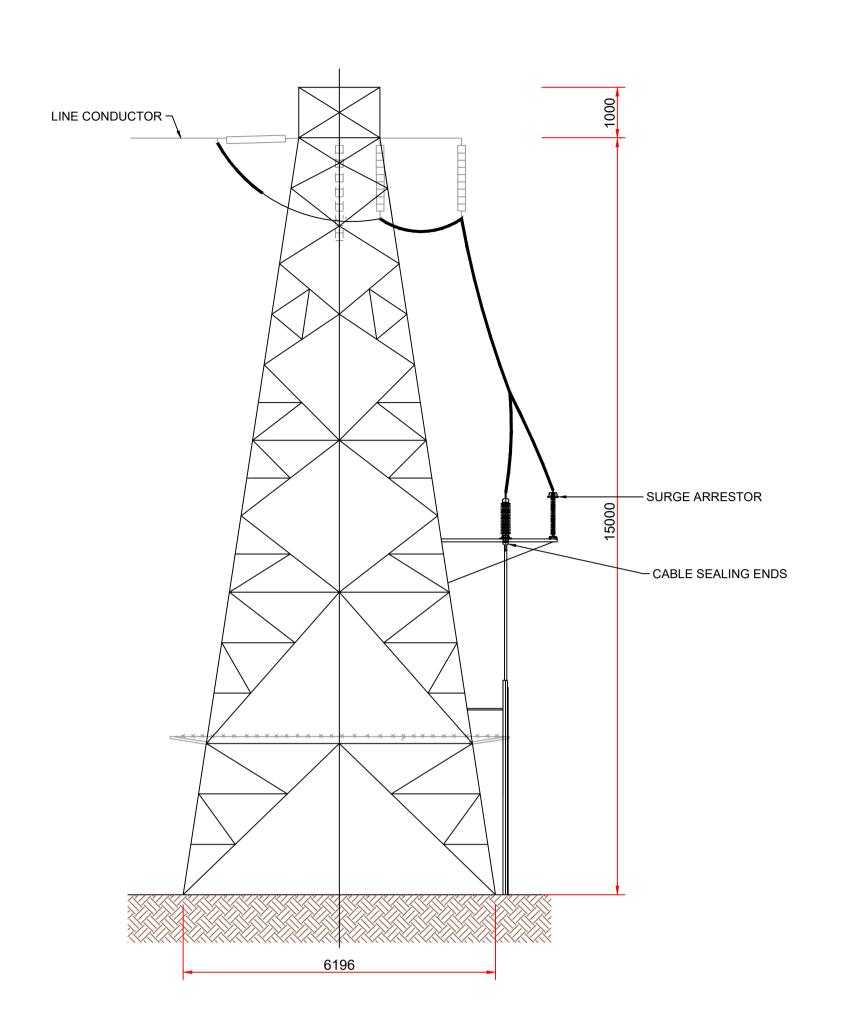


SIDE ELEVATION (SCALE 1:75)

PLEASE NOTE THAT THE COMPONENTS ILLUSTRATED ON THIS DRAWING ARE INDICATIVE ONLY. THE PRECISE SPECIFICATION AND DETAIL WILL BE DETERMINED BY THE ELECTRICAL EQUIPMENT SUPPLIER AND EIRGRID FUNCTIONAL SPECIFICATION

NOTES:

- All dimensions must be checked on site and not scaled from this drawing.
- All dimensions in millimetres unless otherwise

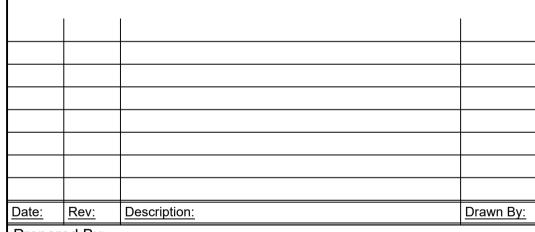

Prepared By:



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Drumlins Park Ltd.

Drumlins Park Wind Farm Substation & Grid Connection

Drawing Title:

Figure 17: Typical 110kV Overhead Line Interface Tower / End Mast

Drawing No.		Revision No.	
DRU001SS_PAG_GA-0.06		Rev 00	
Scale:		Date:	
(A1) 1:75		03/12/2020	
Drawn By:	Checked By	<u>y:</u>	Confirmed By:
J.B.	C.M.P.		S.C.