



FRONT ELEVATION (SCALE 1:75)
(Rear Platform Removed for Clarity)

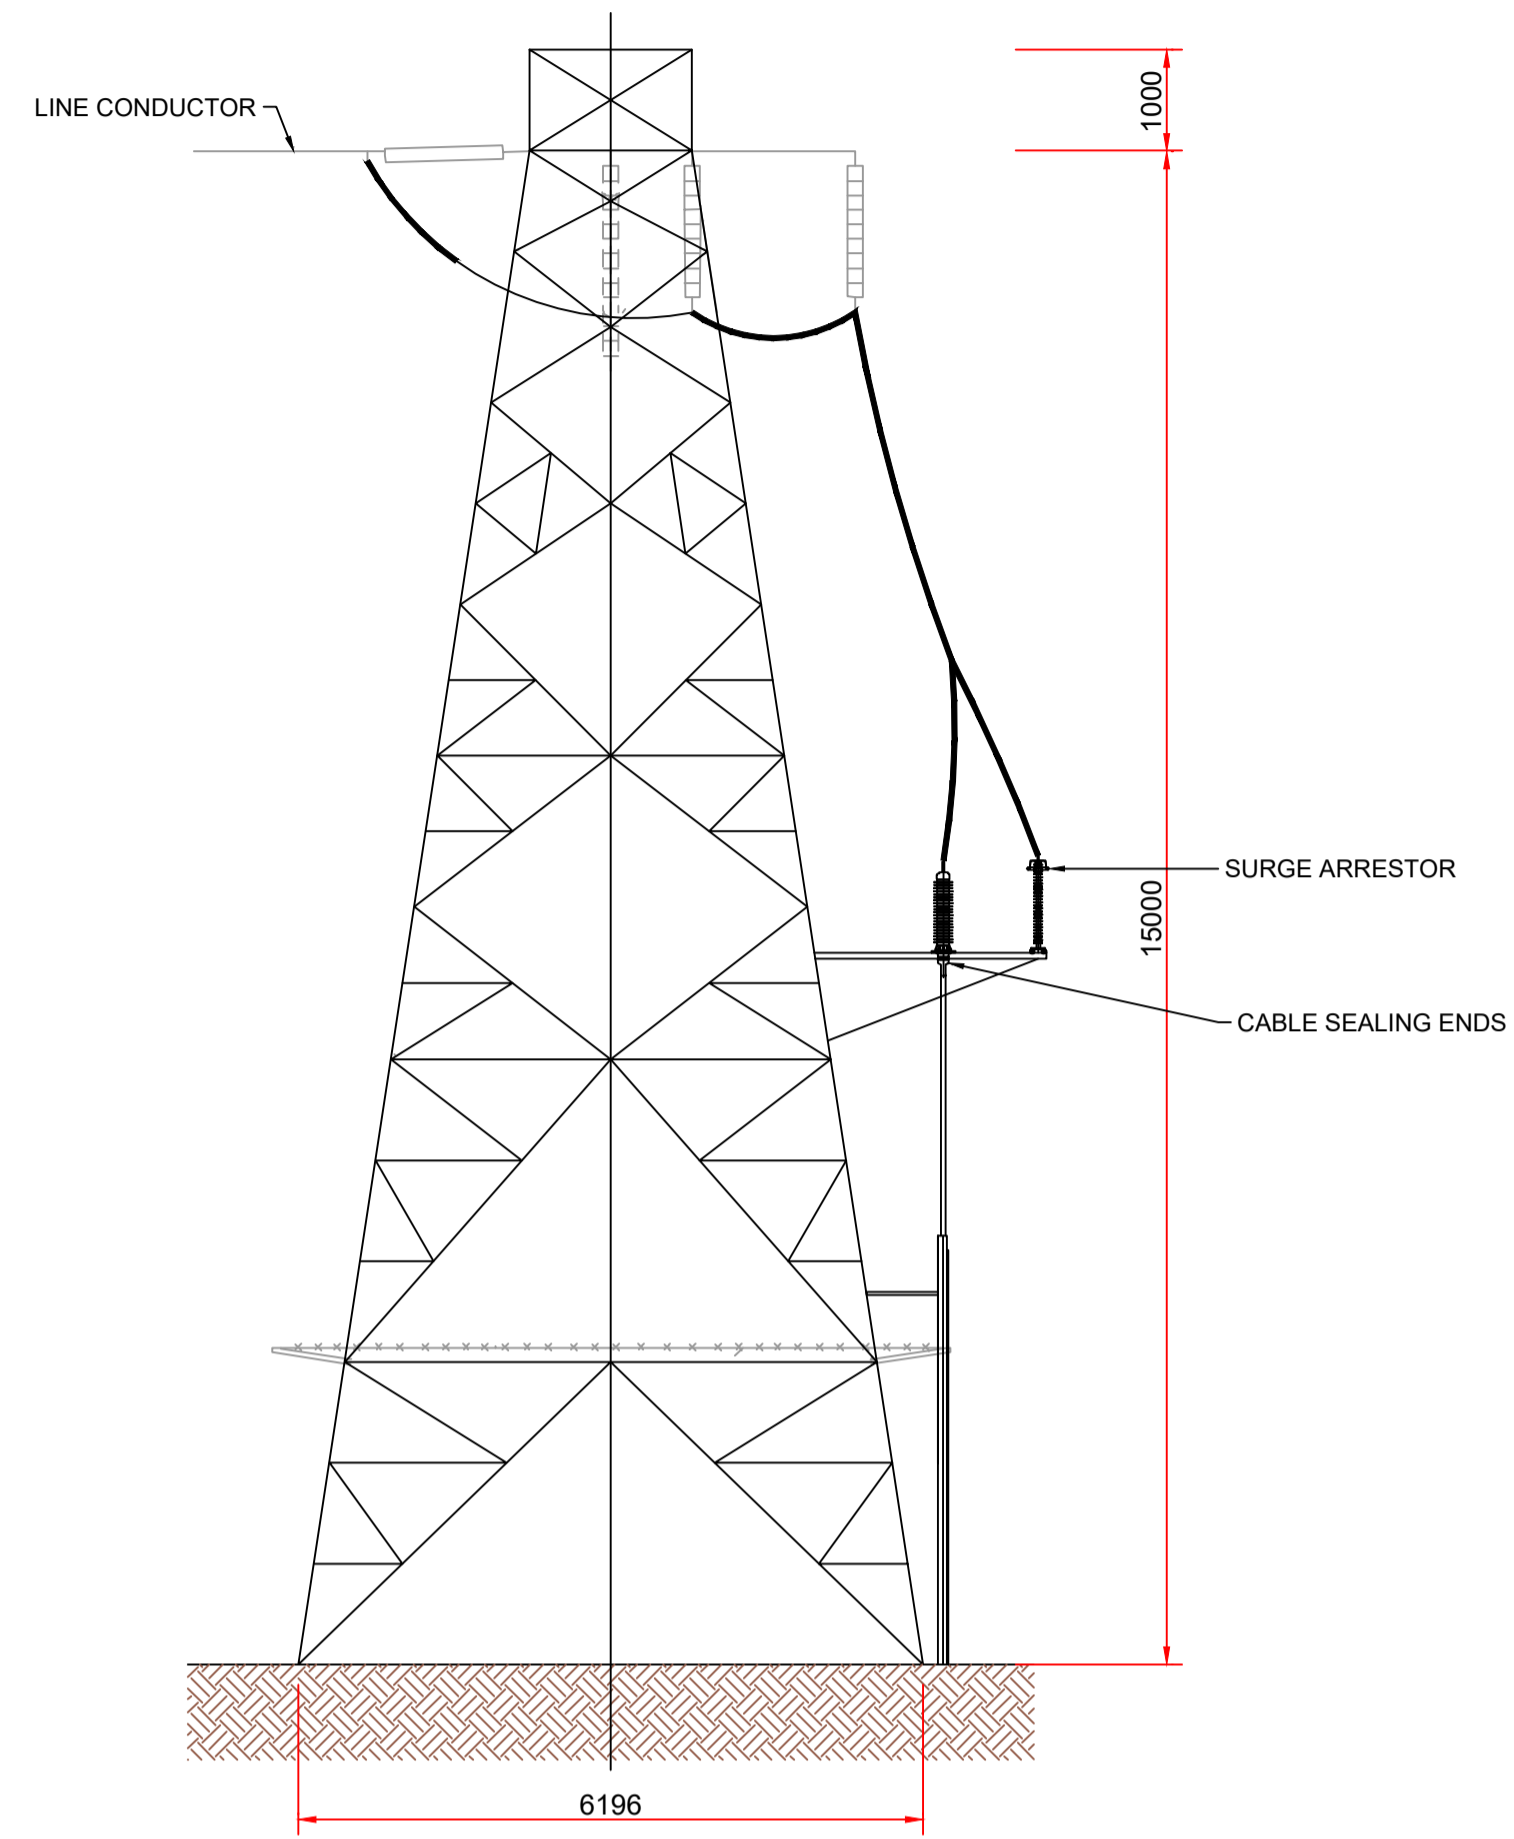

SIDE ELEVATION (SCALE 1:75)

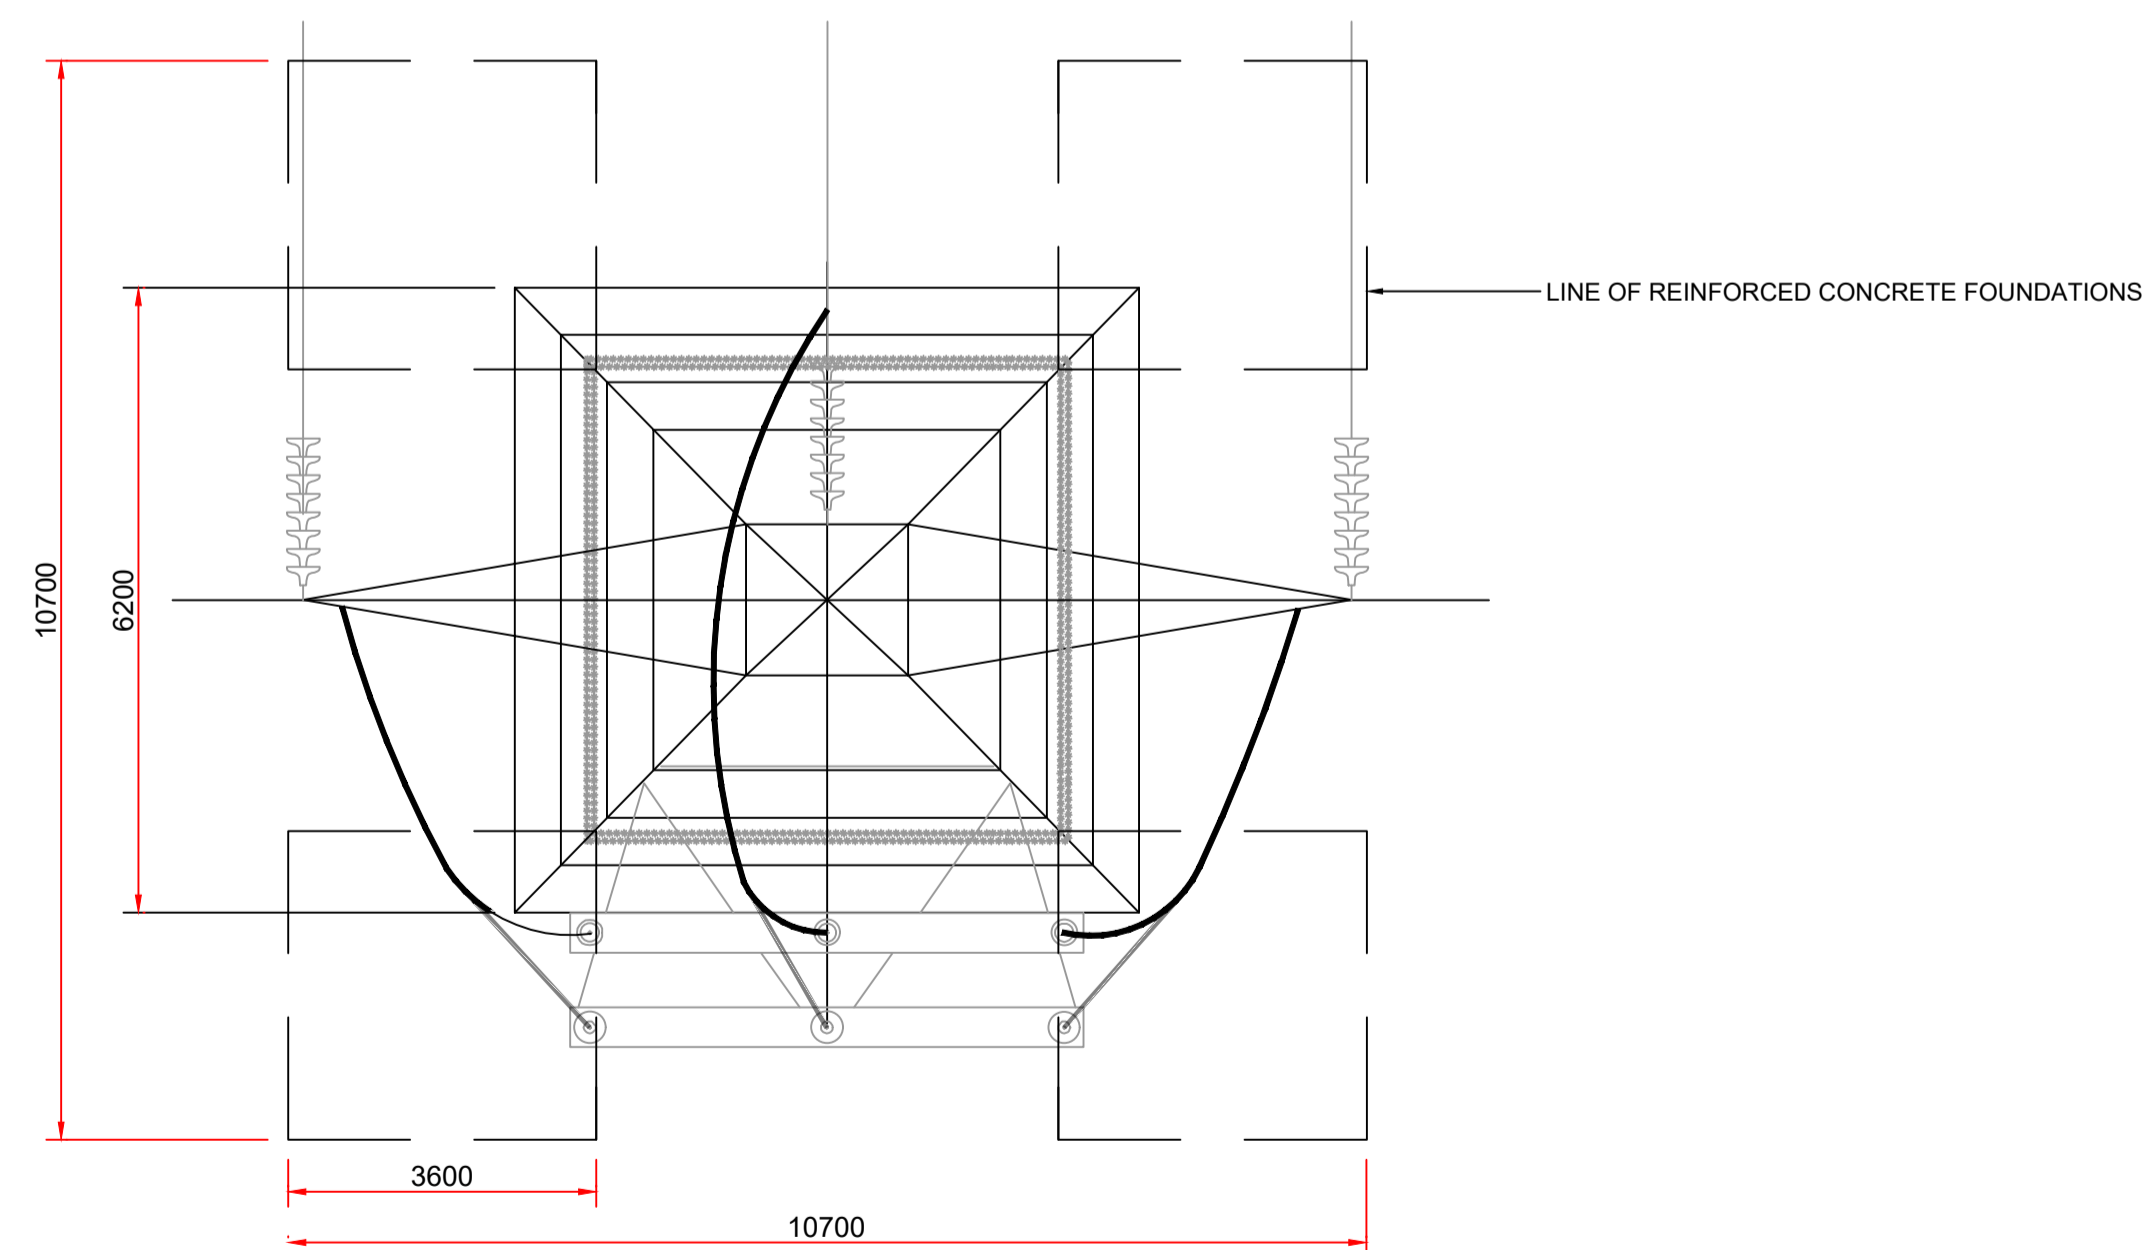

PLAN VIEW (SCALE 1:75)

PLEASE NOTE THAT THE COMPONENTS ILLUSTRATED ON THIS DRAWING ARE INDICATIVE ONLY. THE PRECISE SPECIFICATION AND DETAIL WILL BE DETERMINED BY THE ELECTRICAL EQUIPMENT SUPPLIER AND EIRGRID FUNCTIONAL SPECIFICATION

NOTES:

- All dimensions must be checked on site and not scaled from this drawing.
- All dimensions in millimetres unless otherwise stated

| Date: | Rev: | Description: | Drawn By: |
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Client: **Drumlins Park Ltd.**

Job Title: **Drumlins Park Wind Farm Substation & Grid Connection**

Drawing Title: **Figure 17: Typical 110kV Overhead Line Interface Tower / End Mast**

Drawing No. DRU001SS_PAG_GA-0.06 Revision No. Rev 00

Scale: (A1) 1:75 Date: 03/12/2020

Drawn By: J.B. Checked By: C.M.P. Confirmed By: S.C.